

FARMINGTON

1928 BUILDING COMMITTEE


January 9, 2023



ARCHITECTS
ENGINEERS
INTERIORS




SINCE 1991

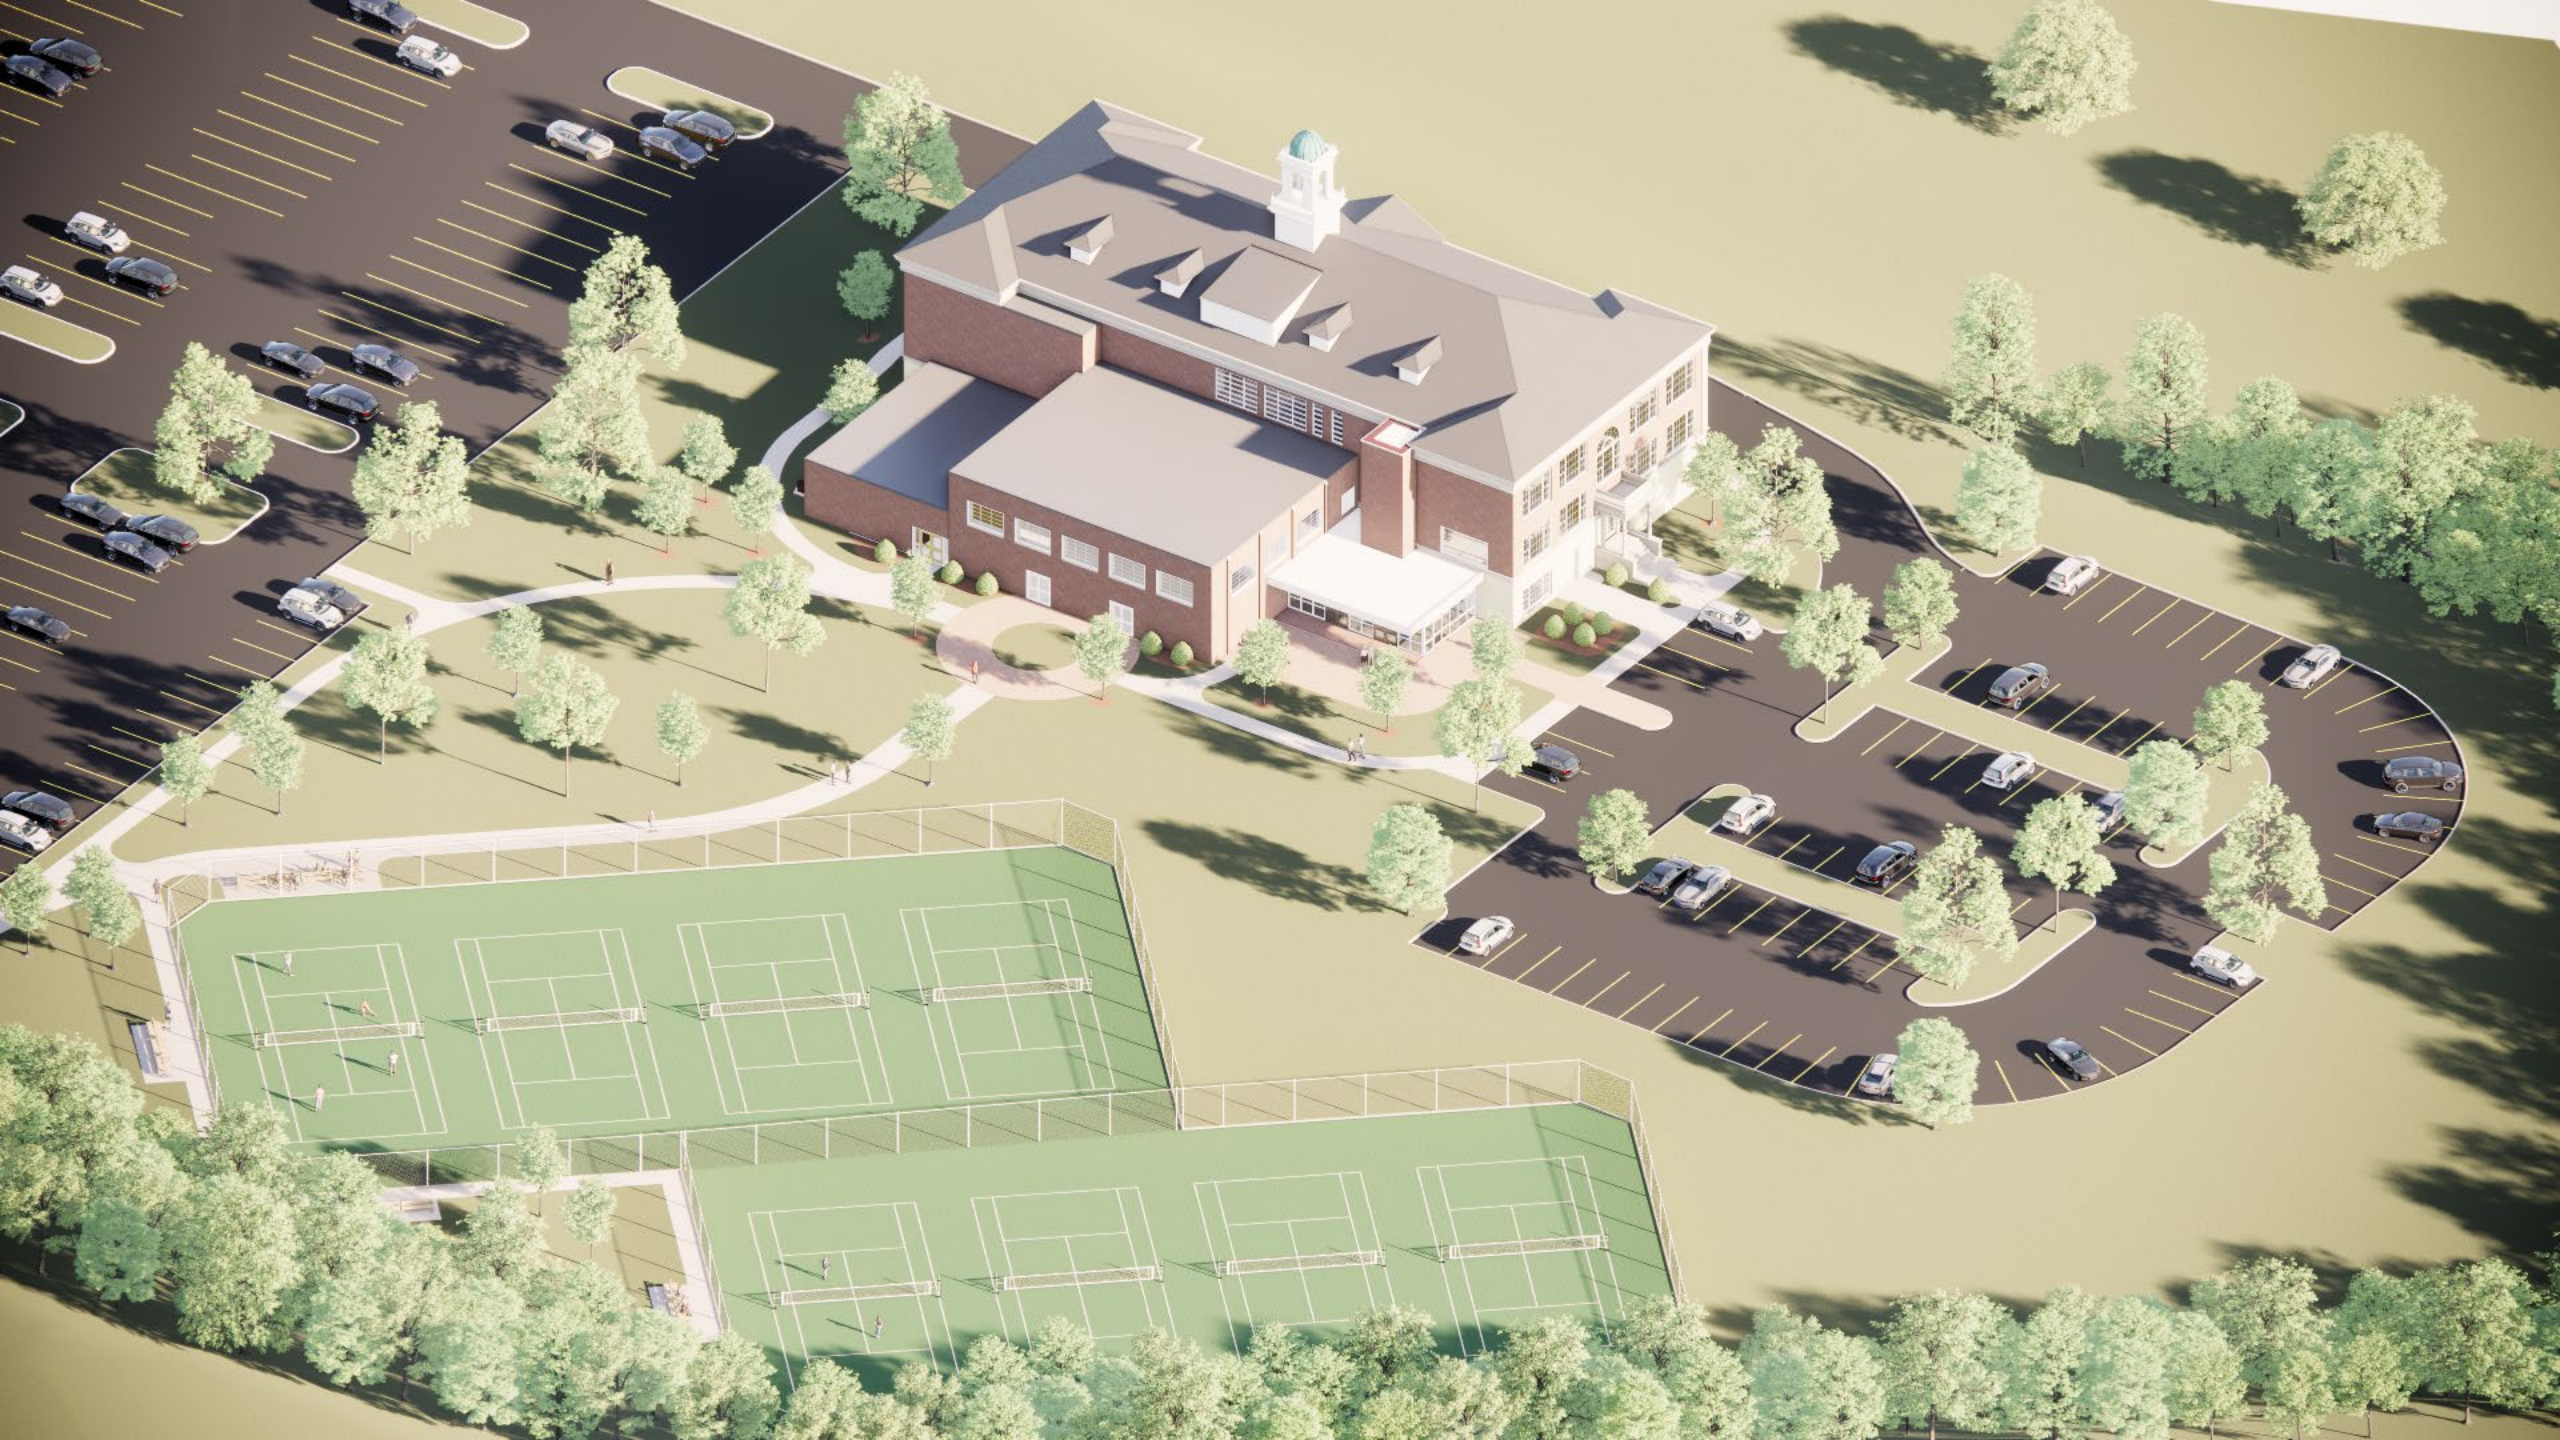





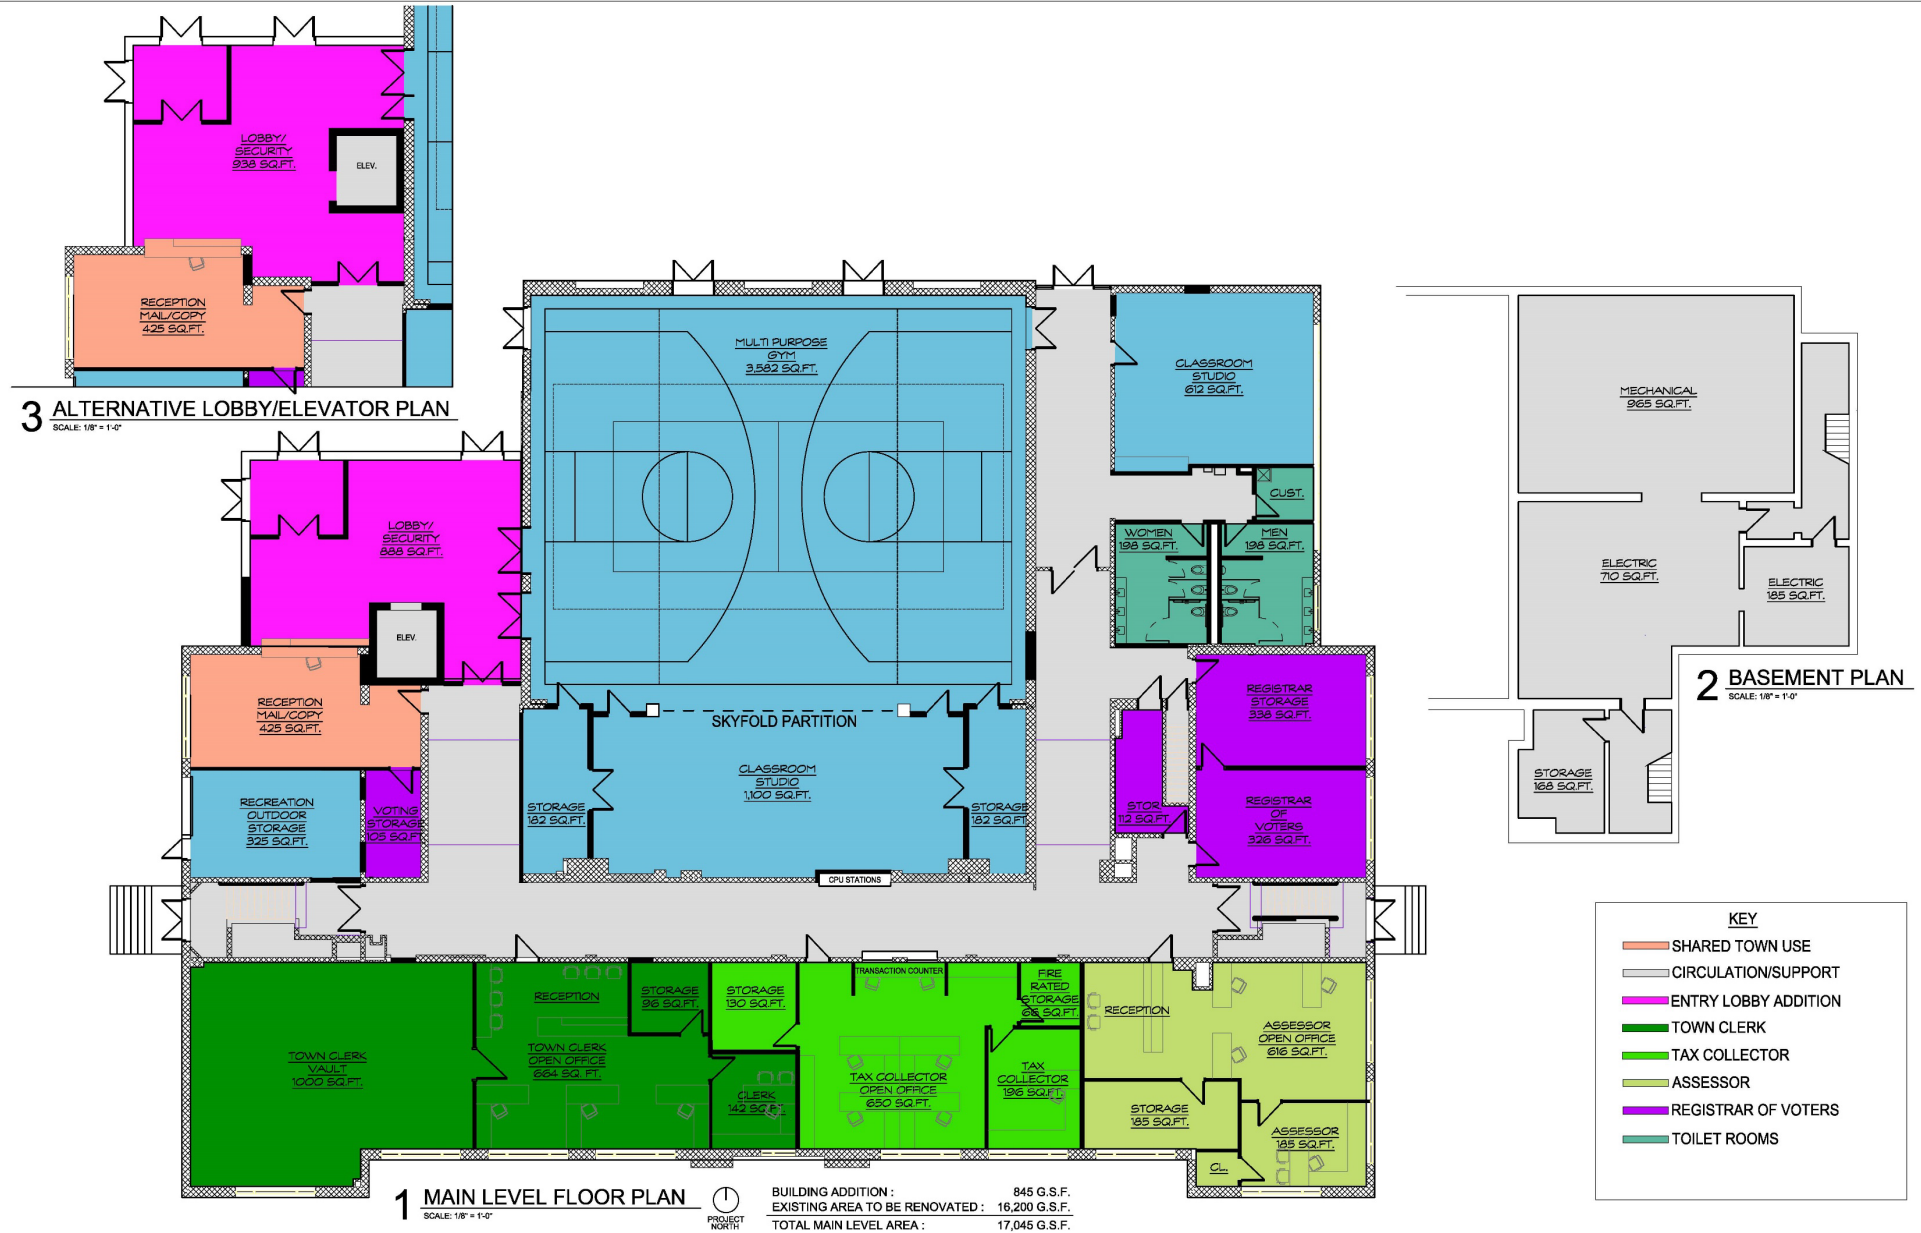

Project Title:
Farmington 1928 Building Renovations

10 Monteith Drive
Farmington, Connecticut 06032



SILVER PETRUCELLI + ASSOCIATES


3190 WHITNEY AVENUE HAMDEN CT 06518
311 STATE STREET NEW LONDON CT 06320
203 230 9007 silverpetrucci.com

Revision	Description	Date	Revised By


Drawing Title:
MAIN LEVEL AND BASEMENT
FLOOR PLAN

Date:
JANUARY 4, 2023
Scale:
1/8" = 1'-0"
Drawn By:
C. NARDI
Project Number:
22-189

Drawing Number:
A110

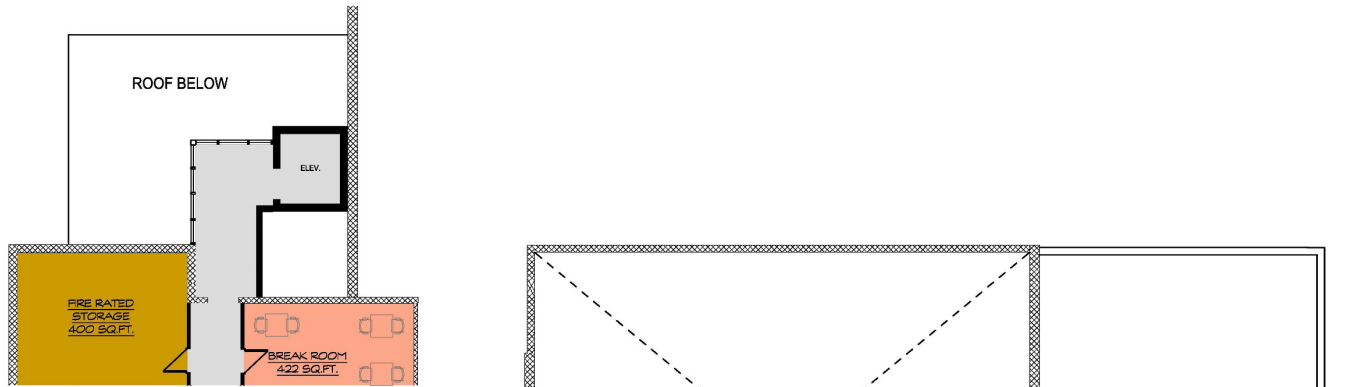

2 ALTERNATIVE ELEVATOR PLAN
SCALE: 1/8" = 1'-0"

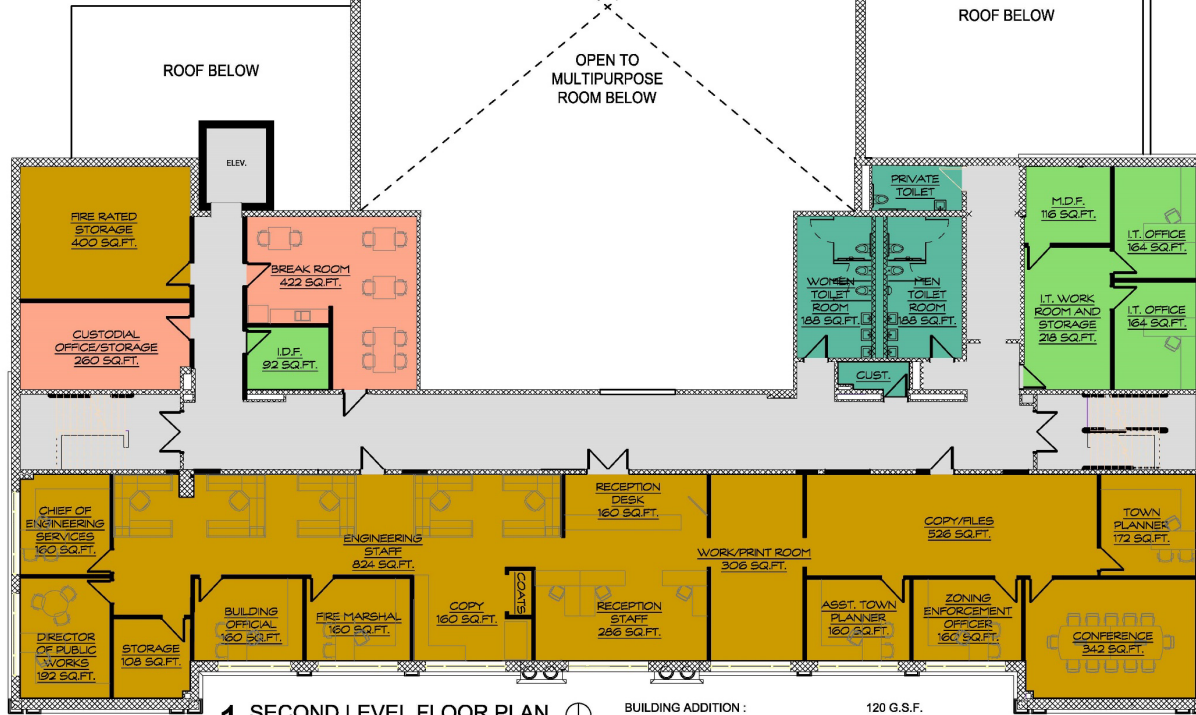

1 SECOND LEVEL FLOOR PLAN
SCALE: 1/8" = 1'-0"

PROJECT NORTH
BUILDING ADDITION : 120 G.S.F.
EXISTING AREA TO BE RENOVATED : 9,440 G.S.F.
TOTAL SECOND LEVEL AREA : 9,560 G.S.F.

KEY

- SHARED TOWN USE
- CIRCULATION
- DEVELOPMENT
- INFORMATION TECHNOLOGY
- TOILET ROOMS

Project Title:
Farmington 1928 Building Renovations

10 Monteith Drive
Farmington, Connecticut 06032



SILVER PETRUCELLI + ASSOCIATES

3190 WHITNEY AVENUE HAMDEN CT 06518
311 STATE STREET NEW LONDON CT 06320
203 230 9007 silverpetrucci.com

Revision	Description	Date	Revised By

Drawing Title:
SECOND LEVEL FLOOR PLAN

Date:
JANUARY 4, 2023

Scale:

1/8" = 1'-0"

Drawn By:


C. NARDI

Project Number:

22-189

Drawing Number:

A111

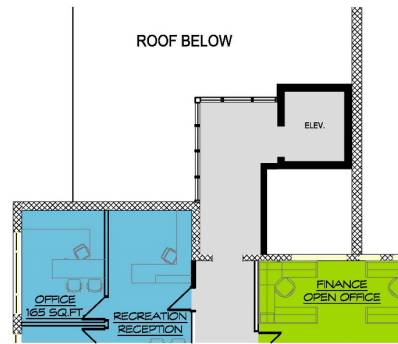

2 ALTERNATIVE LOBBY/ELEVATOR PLAN
SCALE: 1/8" = 1'-0"



1 UPPER LEVEL FLOOR PLAN
SCALE: 1/8" = 1'-0"

BUILDING ADDITION : 120 G.S.F.
EXISTING AREA TO BE RENOVATED : 10,520 G.S.F.
TOTAL MAIN LEVEL AREA : 10,640 G.S.F.

KEY

- SHARED TOWN USE
- CIRCULATION
- TOWN MANAGER
- RECREATION
- FINANCE
- TOILET ROOMS/SUPPORT

Project Title:
Farmington 1928 Building Renovations

10 Monteith Drive
Farmington, Connecticut 06032



SILVER PETRUCELLI + ASSOCIATES

3190 WHITNEY AVENUE HAMDEN CT 06518
311 STATE STREET NEW LONDON CT 06320
203 230 9007 silverpetrucci.com

Revision	Description	Date	Revised By

Drawing Title:
UPPER LEVEL FLOOR PLAN

Date:
NOVEMBER 28, 2022
Scale:
1/8" = 1'-0"
Drawn By:
C. NARDI
Project Number:
22-189

A112

WORK IN PROGRESS



Flagpole Lights

Building Mounted

Building Mounted

Bollards

Cupola Lighting

Building Mounted

Bollards

Bollards

All pole & bollards will match high school fixtures. Building mounted will match existing fixtures

Uplighting?



ARCHITECTS
ENGINEERS
INTERIORS